



21ft HIGH GALLERY WALL


CUTSHEET

PAGE 1 OF 3

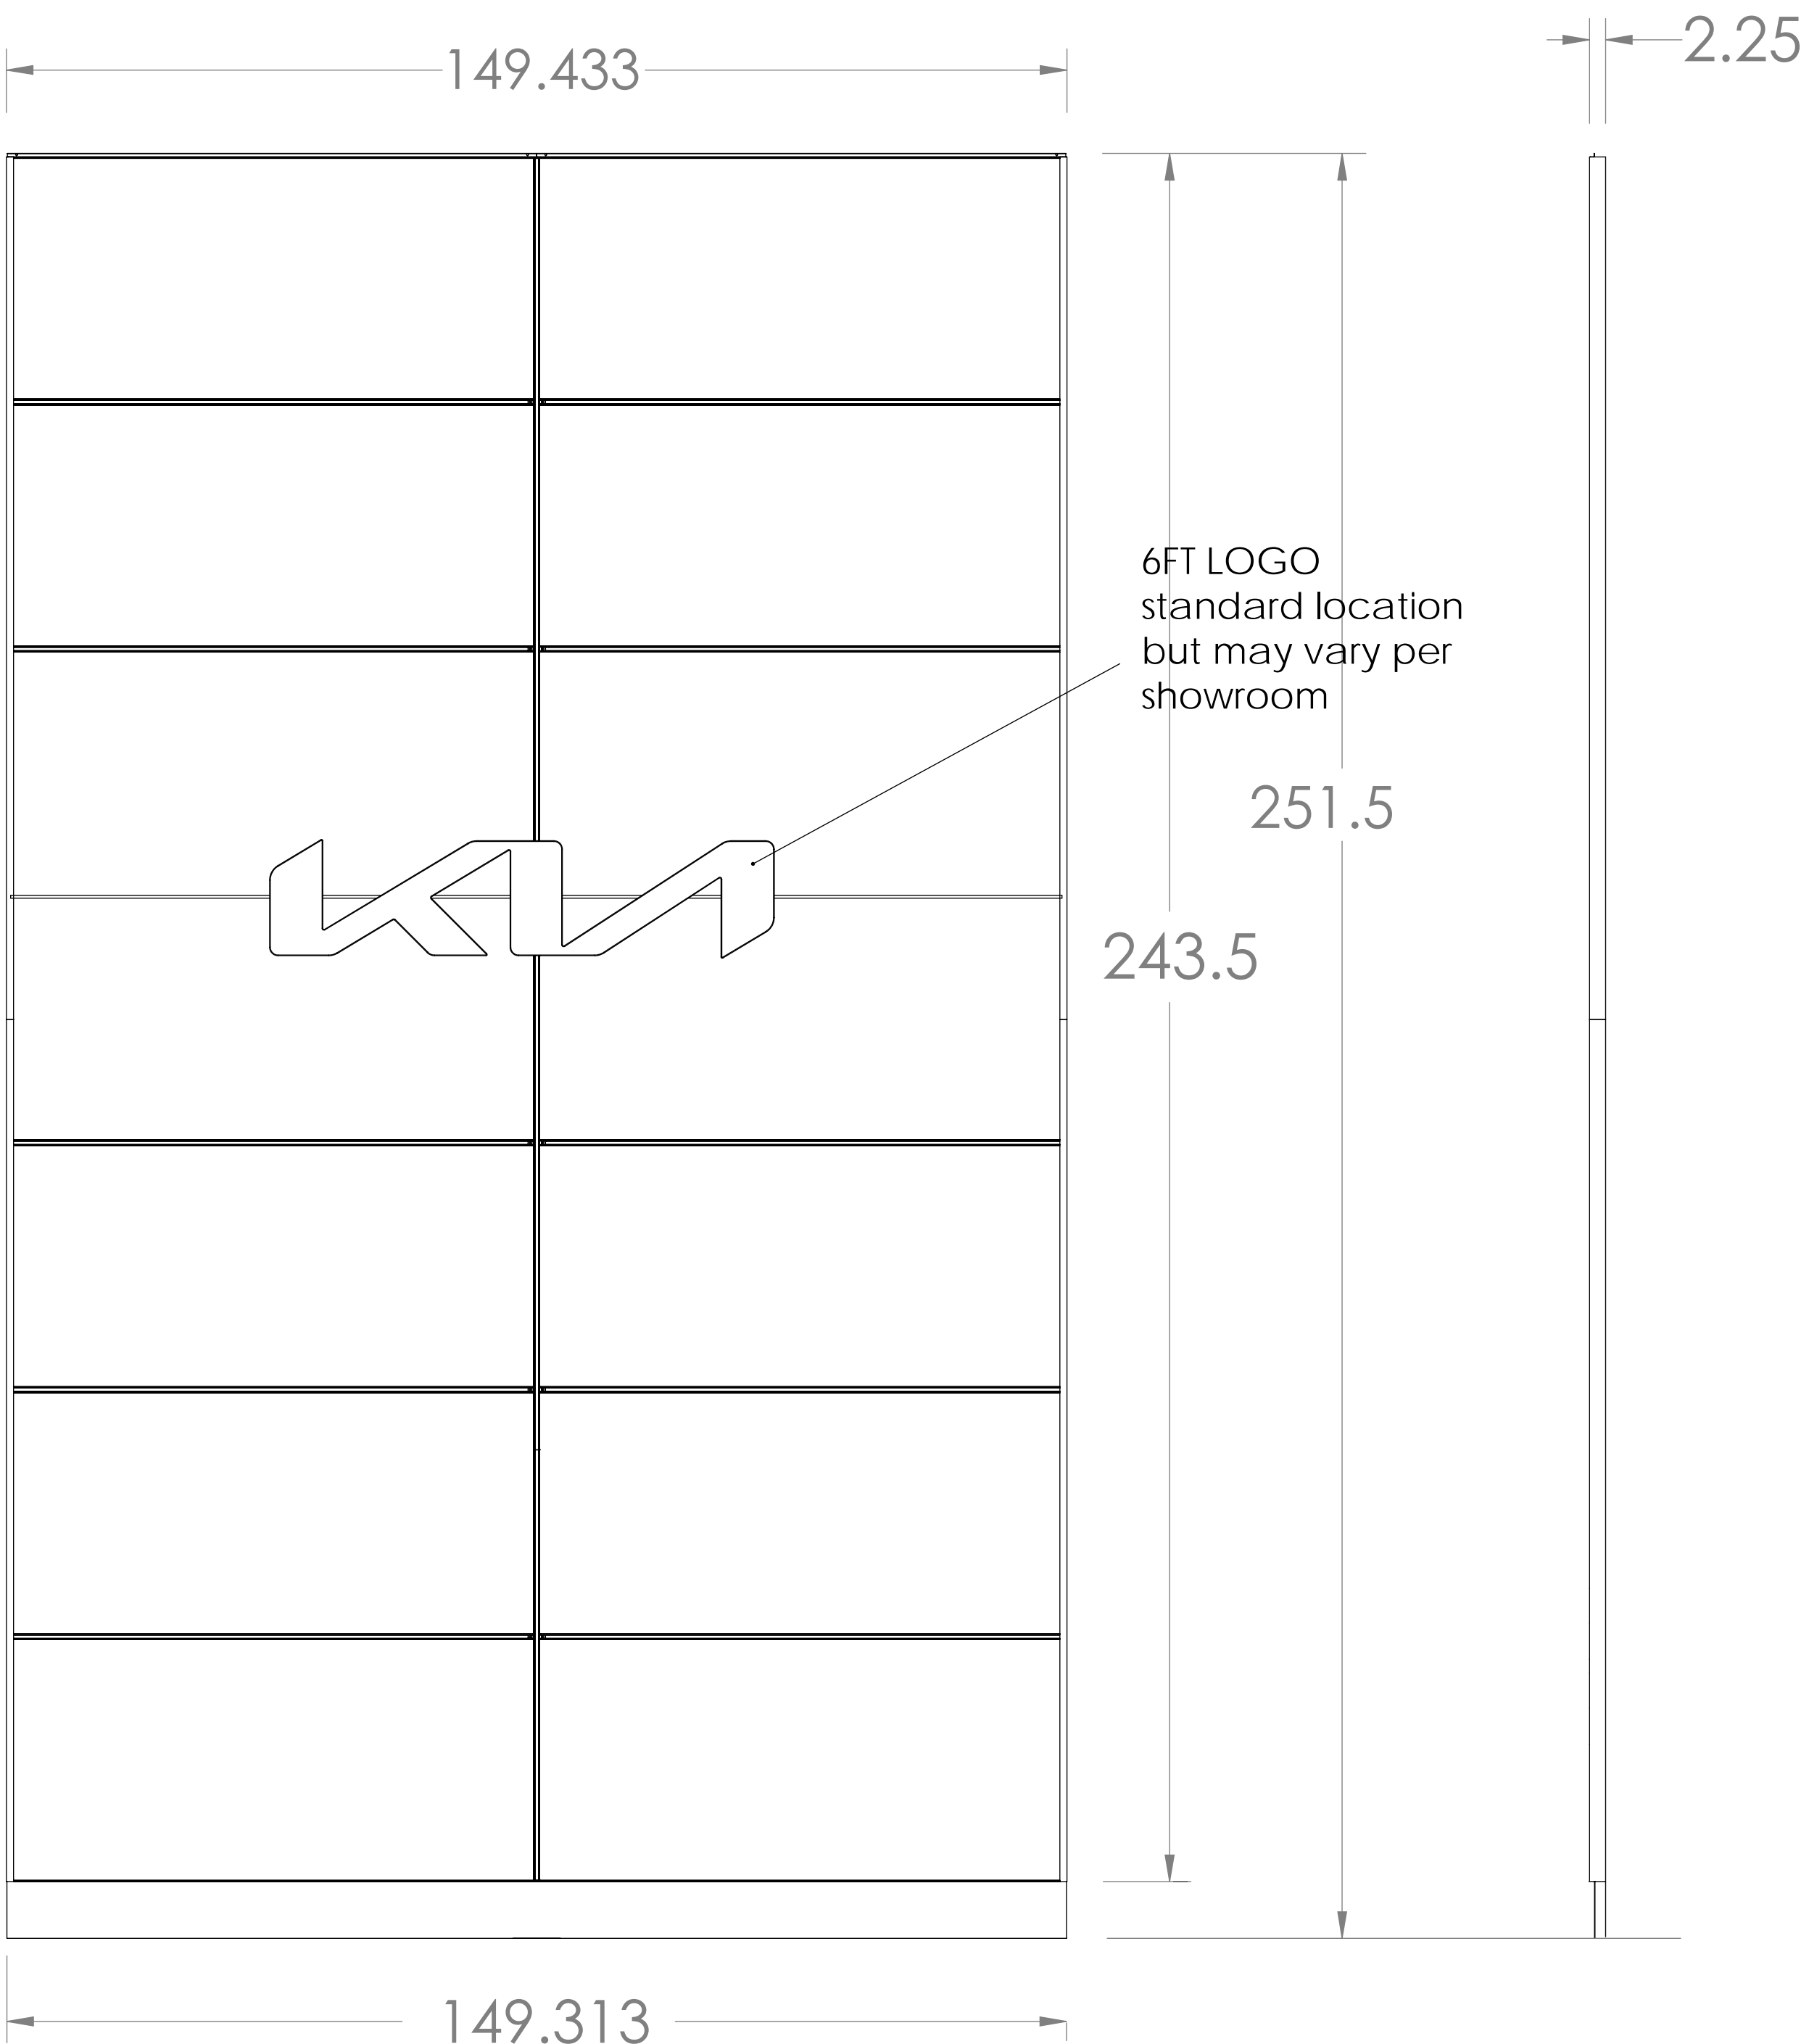

FRONT VIEW

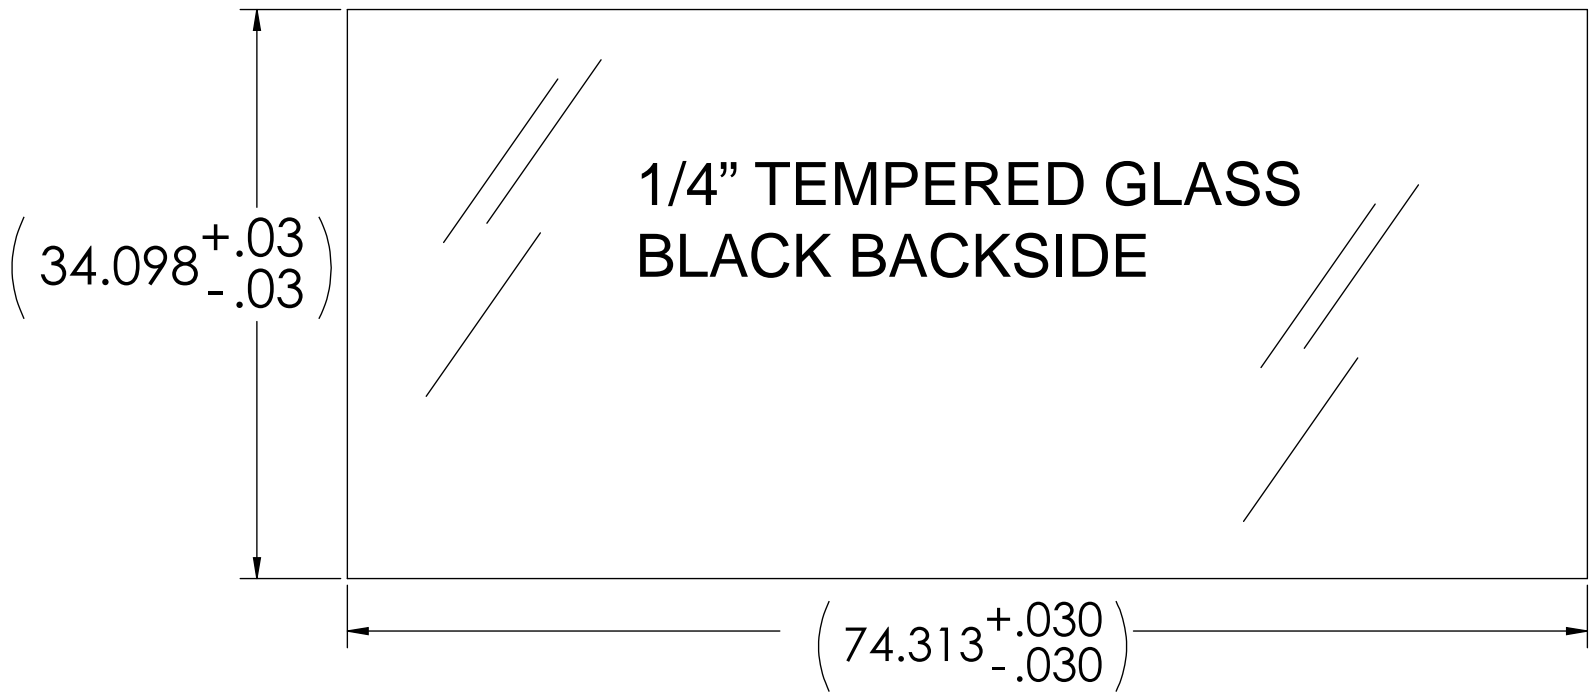

PROJECT NO: P8020				
MATERIAL: -				
WEIGHT: -			PROPRIETARY AND CONFIDENTIAL THE INFORMATION CONTAINED IN THIS DRAWING IS THE SOLE PROPERTY OF DCI MARKETING. ANY REPRODUCTION IN PART OR AS A WHOLE WITHOUT THE WRITTEN PERMISSION OF DCI MARKETING IS PROHIBITED.	
K FACTOR: -				
FINISH: -			DESCRIPTION: 21' GALLERY WALL	
COLOR: -				
VOLUME: -			SIZE DWG. NO. REV	
DRAWN BY: NAME DATE				
CHECKED BY: -			D 9040861 A	
ENG. APPR: NAME DATE				
TOLERANCE: UNLESS OTHERWISE SPECIFIED.			SCALE: 1:24 DO NOT SCALE DRAWING SHEET 1 OF 2	
DECIMAL: .XX ± .03125 .XXX ± .015				
ANGLE: ± 1 DEG.				
FRACTION: ± 1/64				

#1 FOURTEEN BLACK GLASS
PANELS
21ft WALL VERSION
74.31" X 34" EACH

#6 FOURTEEN
WALL PLATES

#3 FOUR VERTICAL
DIVIDERS

#5 TWO HORIZONTAL
TOP CAPS


#4 TWELVE HORIZONTAL
DIVIDERS

#7 FOUR SIDE
EXTRUSIONS

#2 TWO BOTTOM
EXTRUSIONS

#8 TWO BLACK KICK
PANELS

21ft HIGH GALLERY WALL
CUTSHEET

PROJECT NO: P8020			<div></div> <div>PROPRIETARY AND CONFIDENTIAL</div> <div>THE INFORMATION CONTAINED IN THIS DRAWING IS THE SOLE PROPERTY OF DCI PRODUCTS. ANY REPRODUCTION IN PART OR AS A WHOLE WITHOUT THE WRITTEN PERMISSION OF DCI PRODUCTS IS PROHIBITED.</div> <div>DESCRIPTION:</div> <div>21' GALLERY WALL</div>		
MATERIAL: -					
BEND DEDUCTION: -					
K FACTOR: -					
FINISH: -					
COLOR: -					
VOLUME: -					
DRAWN BY:					
CHECKED BY: -					
ENG. APPR:					
TOLERANCE: UNLESS OTHERWISE SPECIFIED.			SIZE DWG. NO. REV <div>D9040861A</div>		
DECIMAL .XX ± .03125					
XXX ± .015					
ANGLE ± 1 DEG.					
FRACTION ± 1/64			SCALE: 1:48 DO NOT SCALE DRAWING		
			SHEET 2 OF 2		

LEGEND	
?-#	FINISH DESIGNATOR - REFER TO SCHEDULES ON A-5B SERIES SHEETS.
EG-X G-X	GRAPHICS DESIGNATOR - REFER TO "G" SERIES SHEETS FOR DESCRIPTION

21ft HIGH GALLERY WALL

CUTSHEET

PAGE 3 OF 3


GENERAL NOTES

- A. ALL CEILING HEIGHTS SHOWN ARE BASED UPON A GROUND-UP PROTOTYPICAL STRUCTURE. MODIFICATIONS AND SUBJECTIVE ANALYSIS MAY BE REQUIRED IN RETROFIT CONDITIONS.
- B. PREFERRED CONDITIONS SHOWN. MODIFY AS REQUIRED PER PLAN.
- C. REFER TO REFLECTED CEILING PLAN ON SHEET A-6.1 FOR ACTUAL CEILING HEIGHTS.
- D. ALL WALLS TO BE WC-1 UNLESS OTHERWISE NOTED.

#


DRAWING NOTES

1. DISCLAIMER: CONTRACTOR RESPONSIBLE TO CONTACT MANUFACTURER REGARDING TECHNICAL QUESTIONS, CURRENT INSTALLATION, AND ADHESIVE RECOMMENDATIONS. ALL MEANS AND METHODS OF INSTALLATION TO BE VERIFIED BY ARCHITECT OF RECORD. COORDINATE APPROPRIATE HARDWARE AND INSTALLATION WITH GL-1 MANUFACTURER ON FINISH SCHEDULE ON SHEET A-5B.1.
2. INSTALL "L" TRIM PIECE
3. METAL STUD FRAMING, ANCHORED TO FLOOR AND CEILING STRUCTURE.
4. DRYWALL.

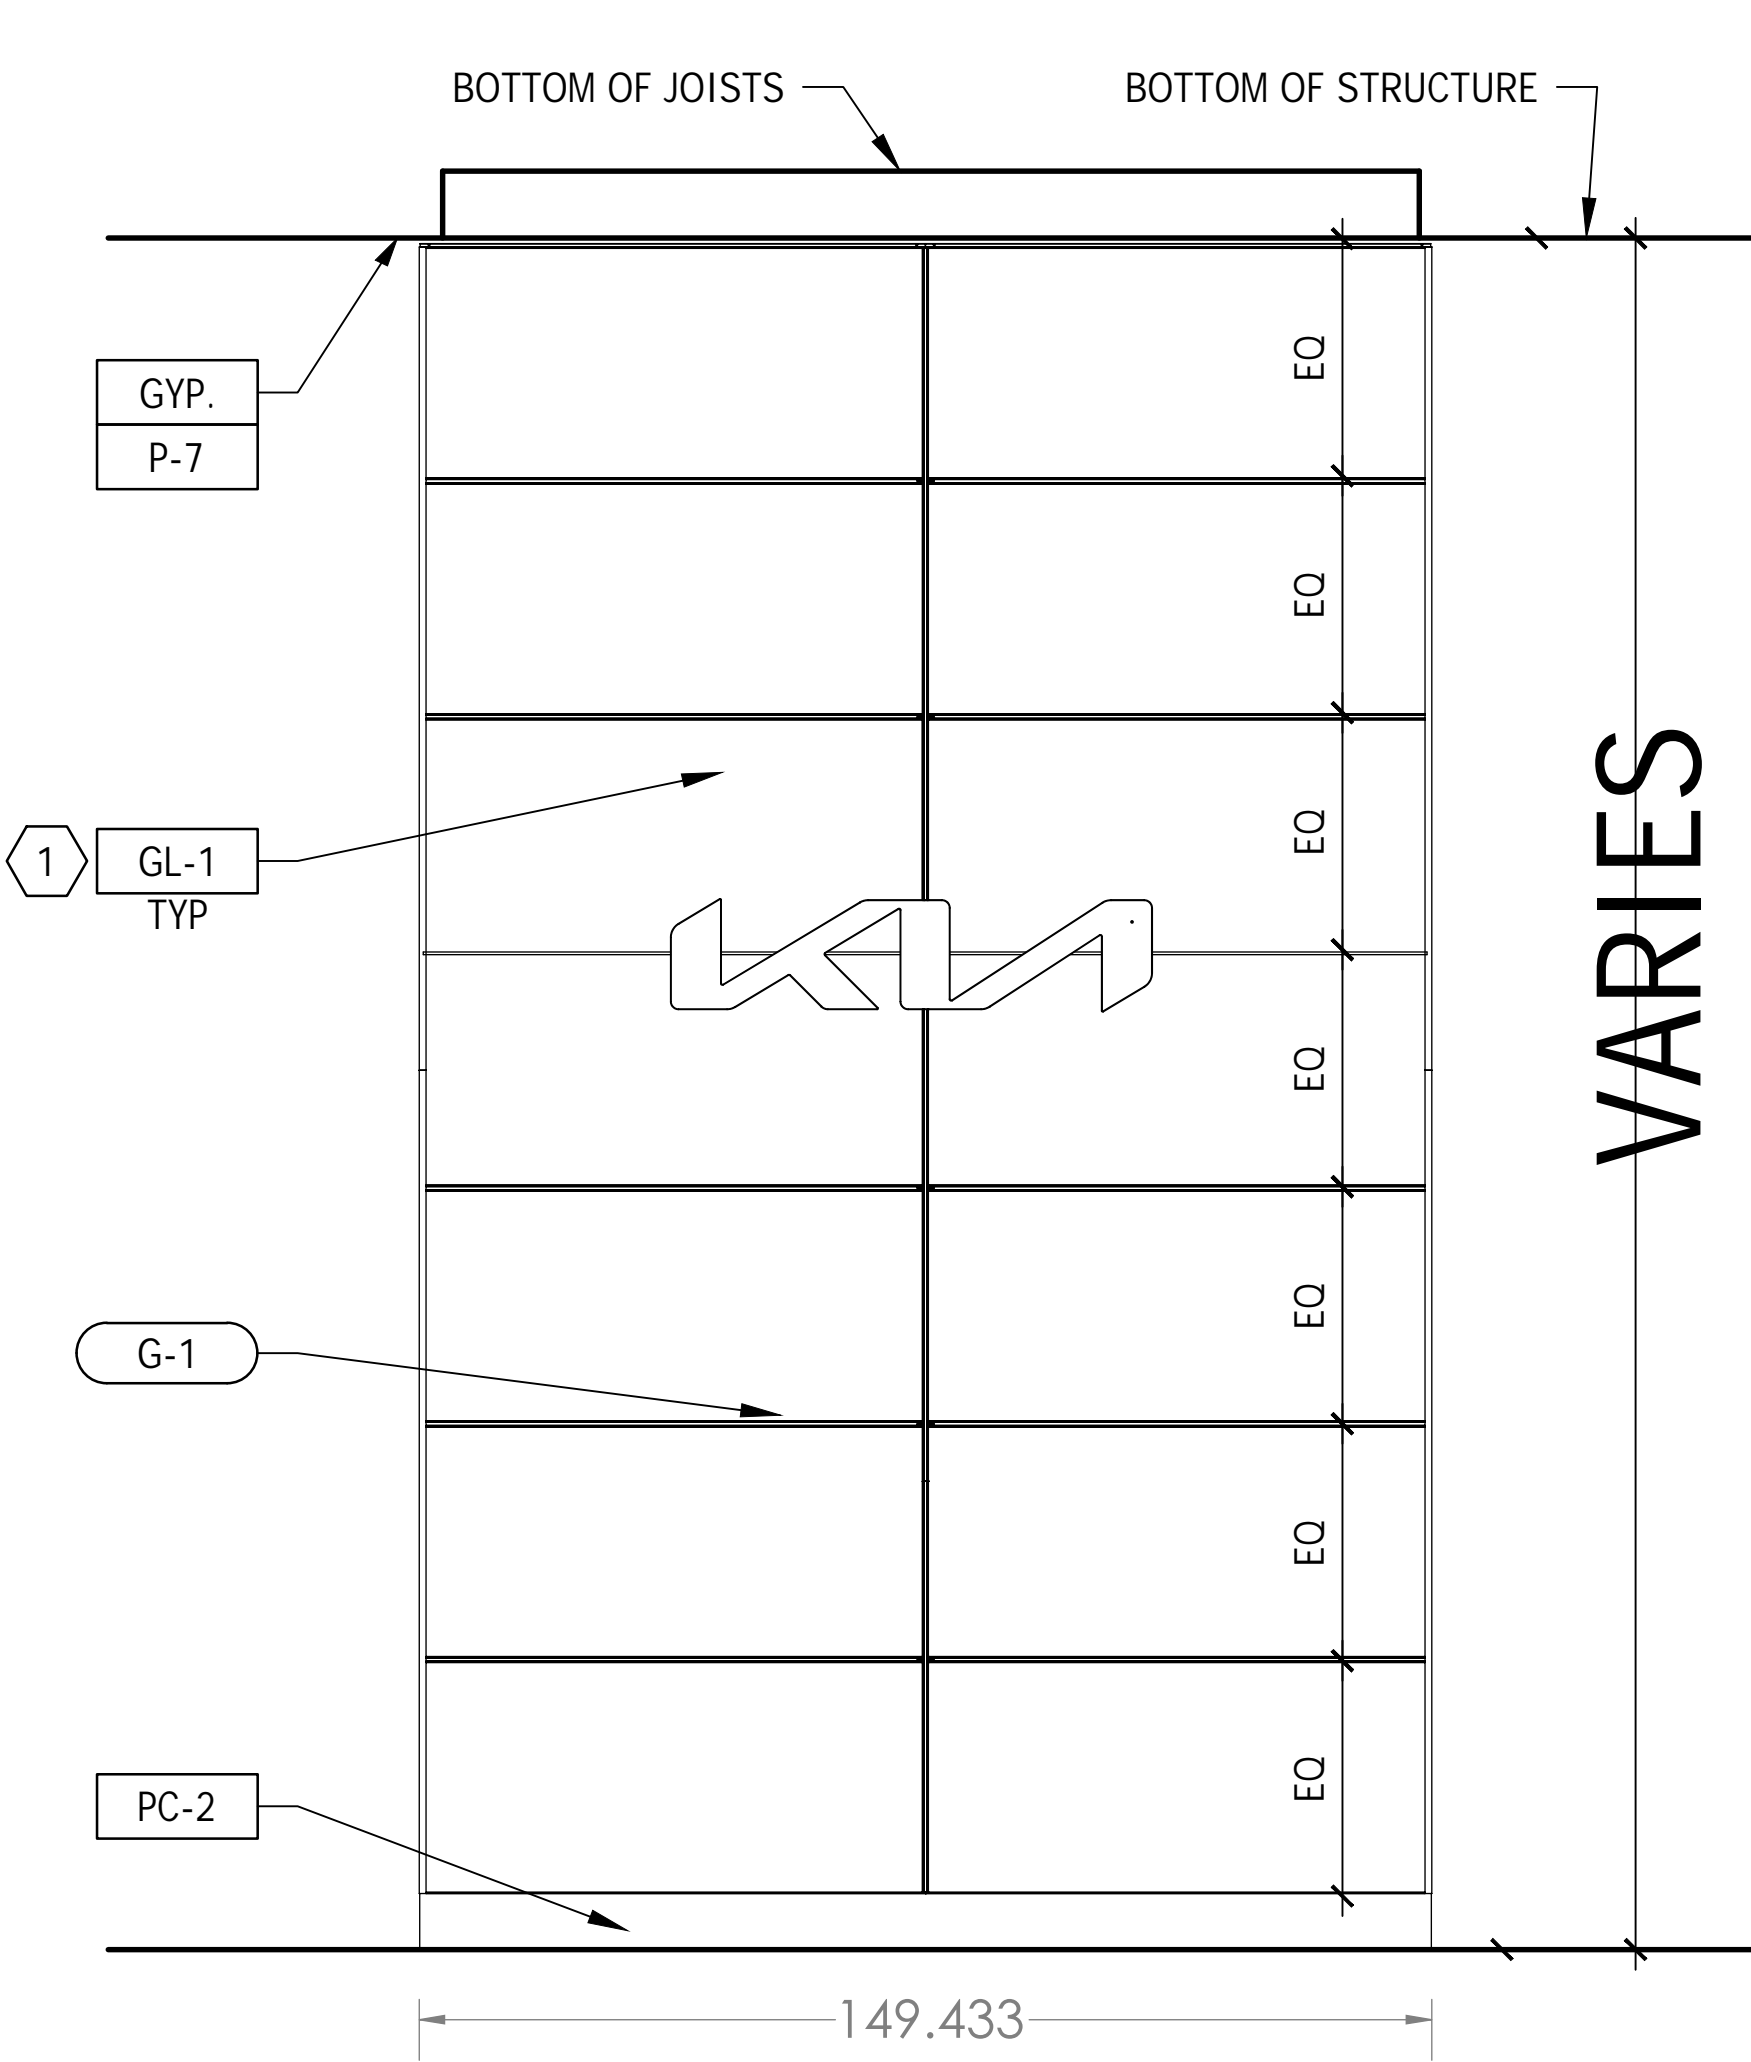


BRAND WALL FRONT ELEVATION

3/16" = 1'-0"

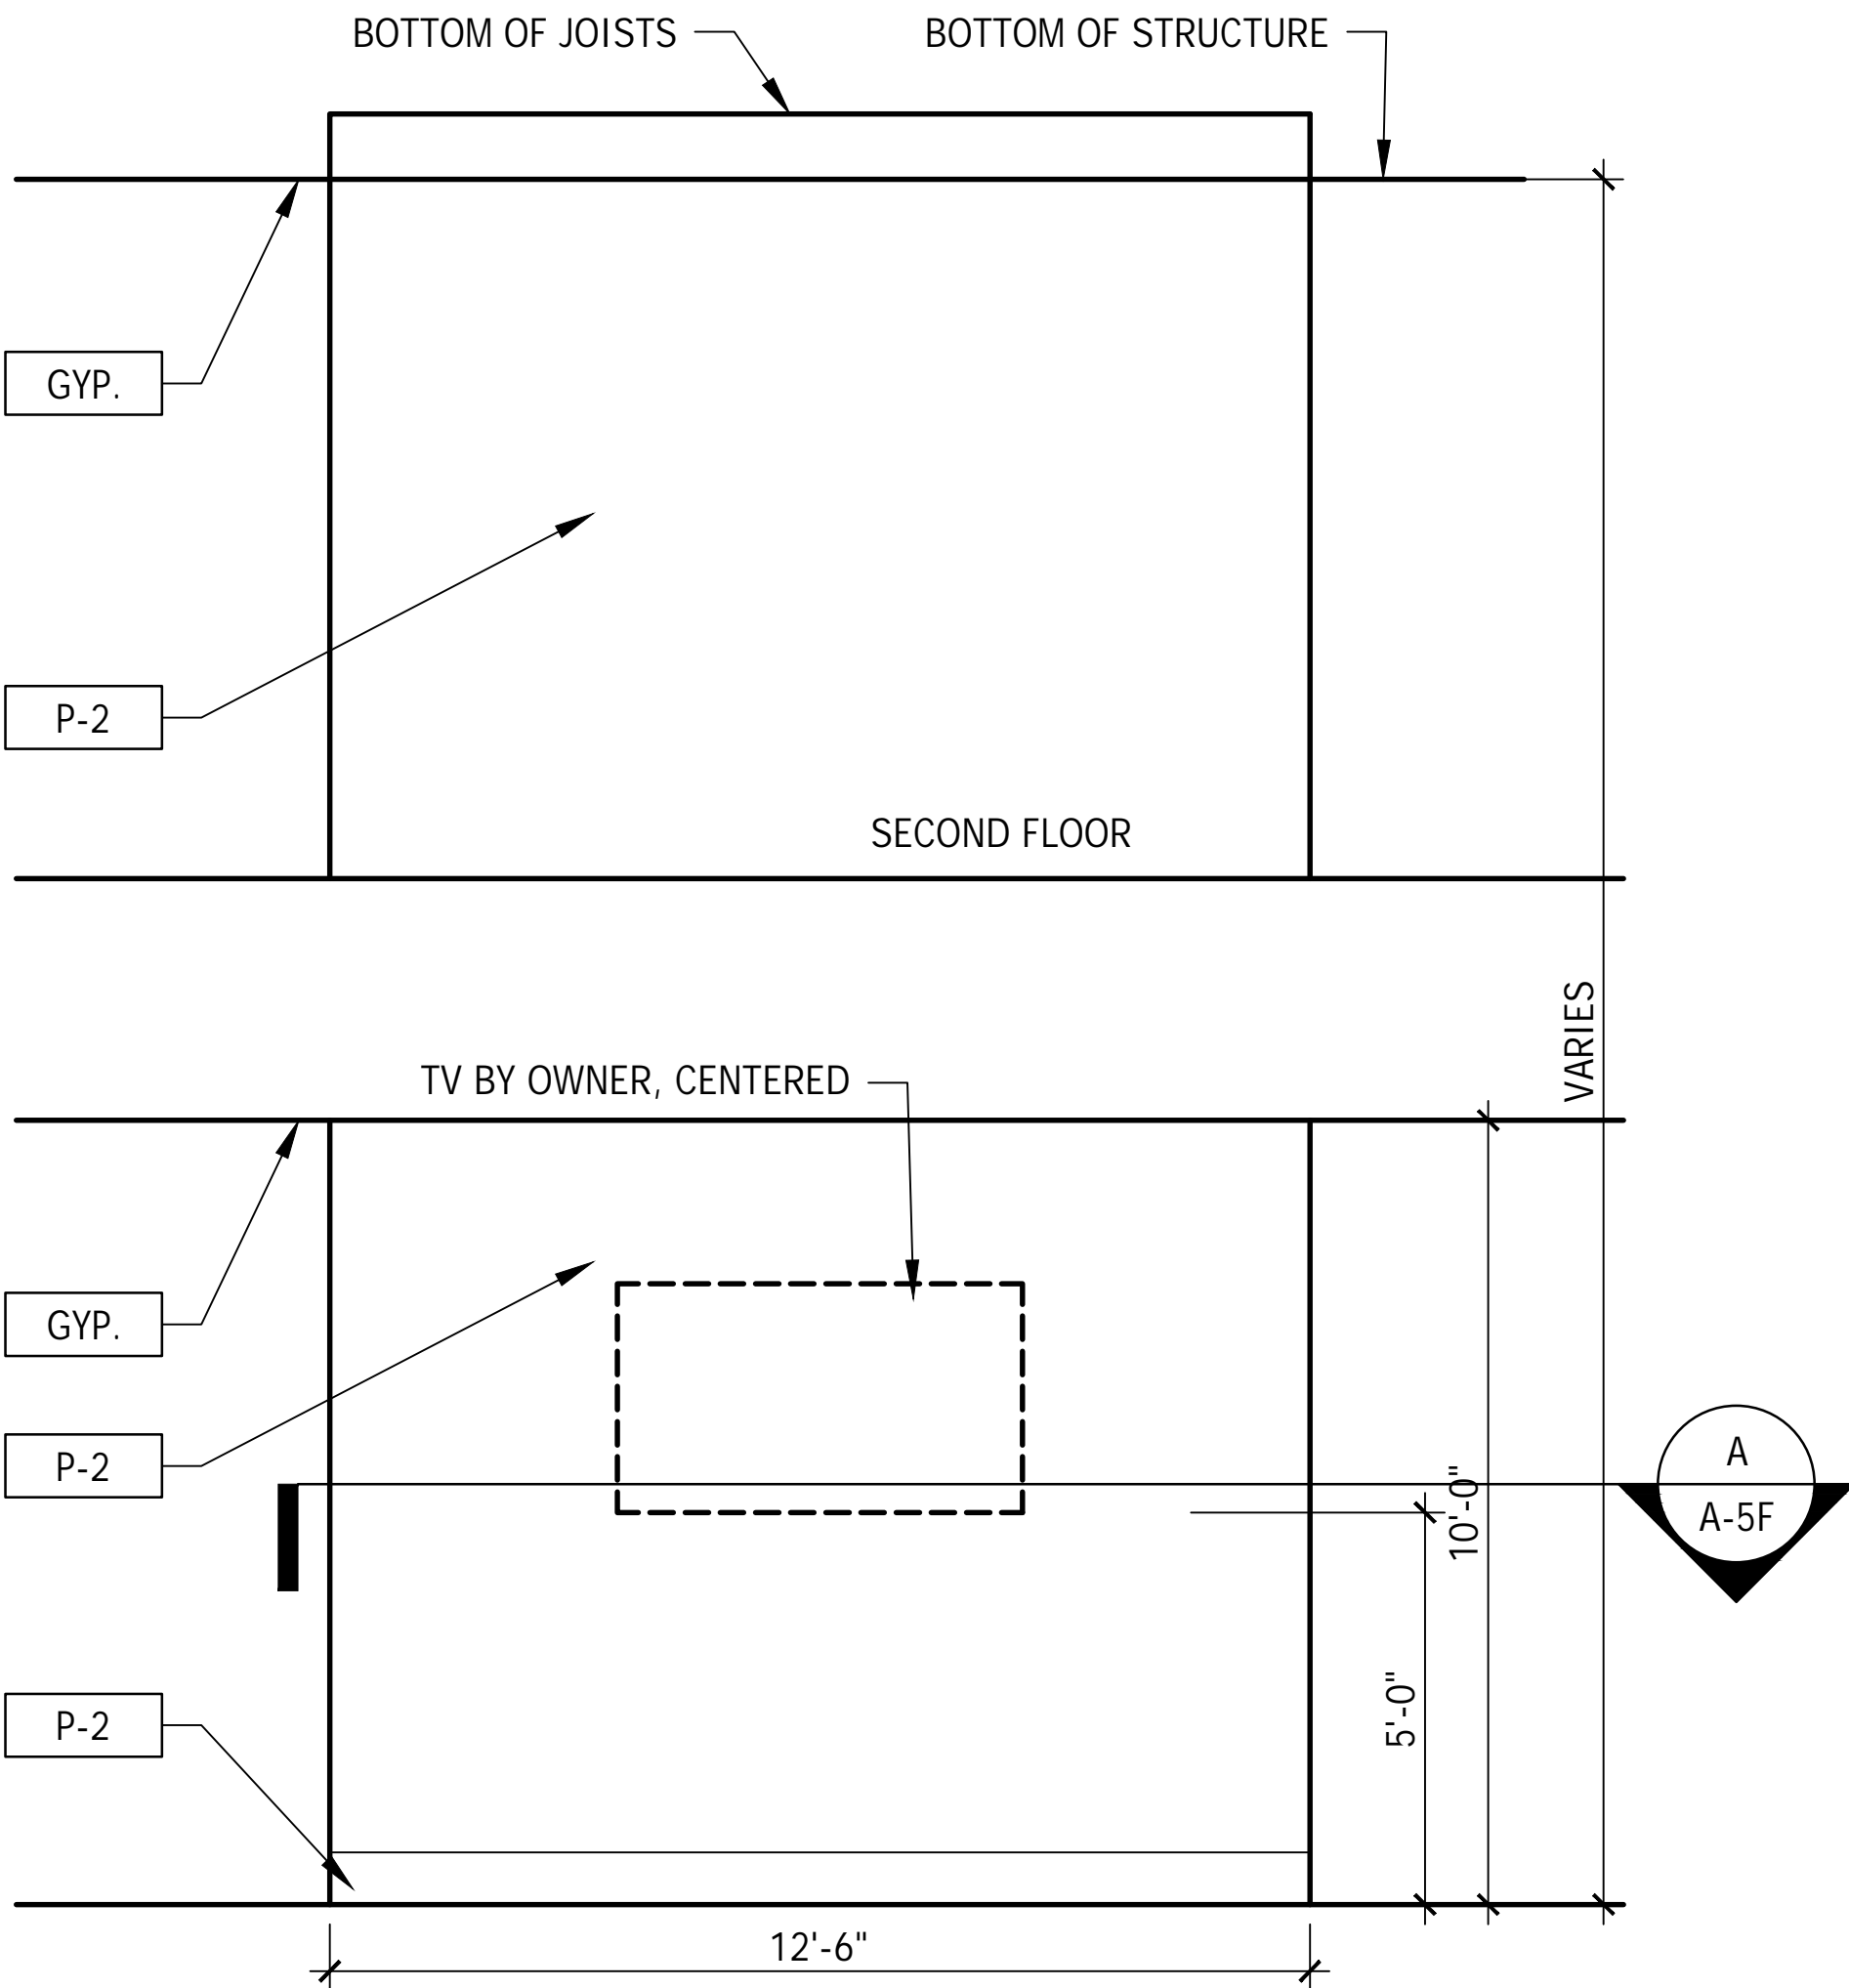

BRAND WALL REAR ELEVATION

3/16" = 1'-0"

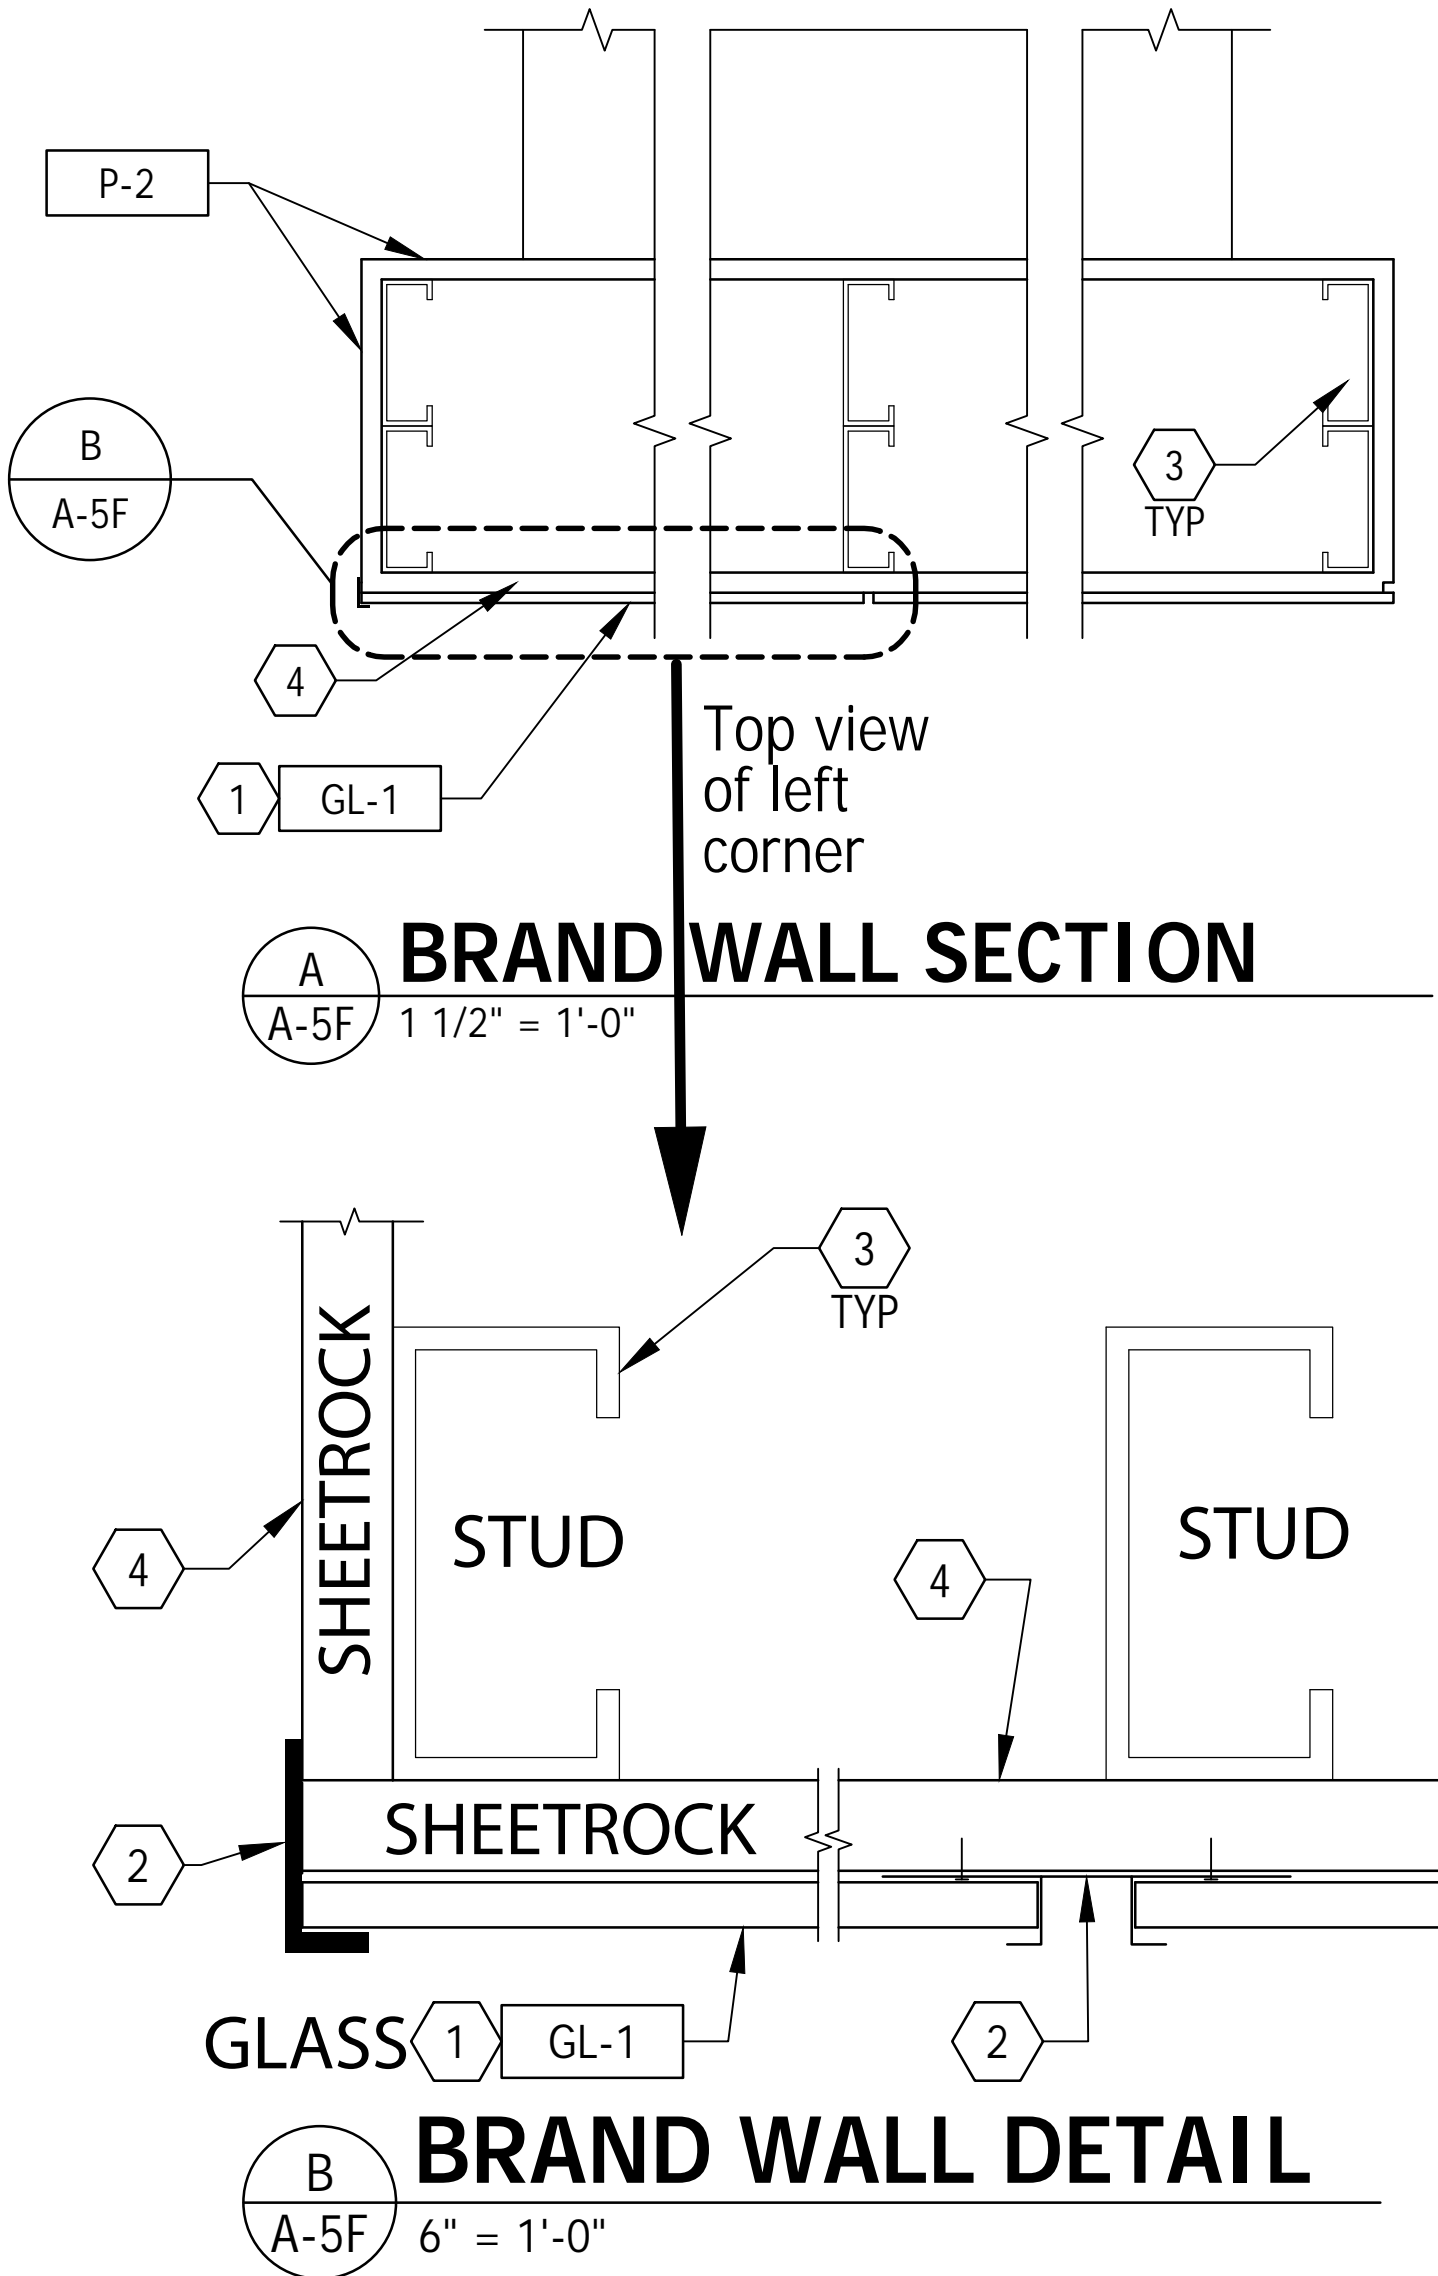

BRAND WALL DETAIL

Top view of left corner

DATE	
OCTOBER 2022	
REVISED	
CG + ND	
SCALE	PROJECT NO.
	KIA00.11
DRAWING TITLE	
BRAND AND WALL DETAILS	
DWG NO.	
A-5F	